
# ROBBINS LIBRARY

# EXTERIOR ENVELOPE REPAIRS - PHASE IA BID NO.19-58

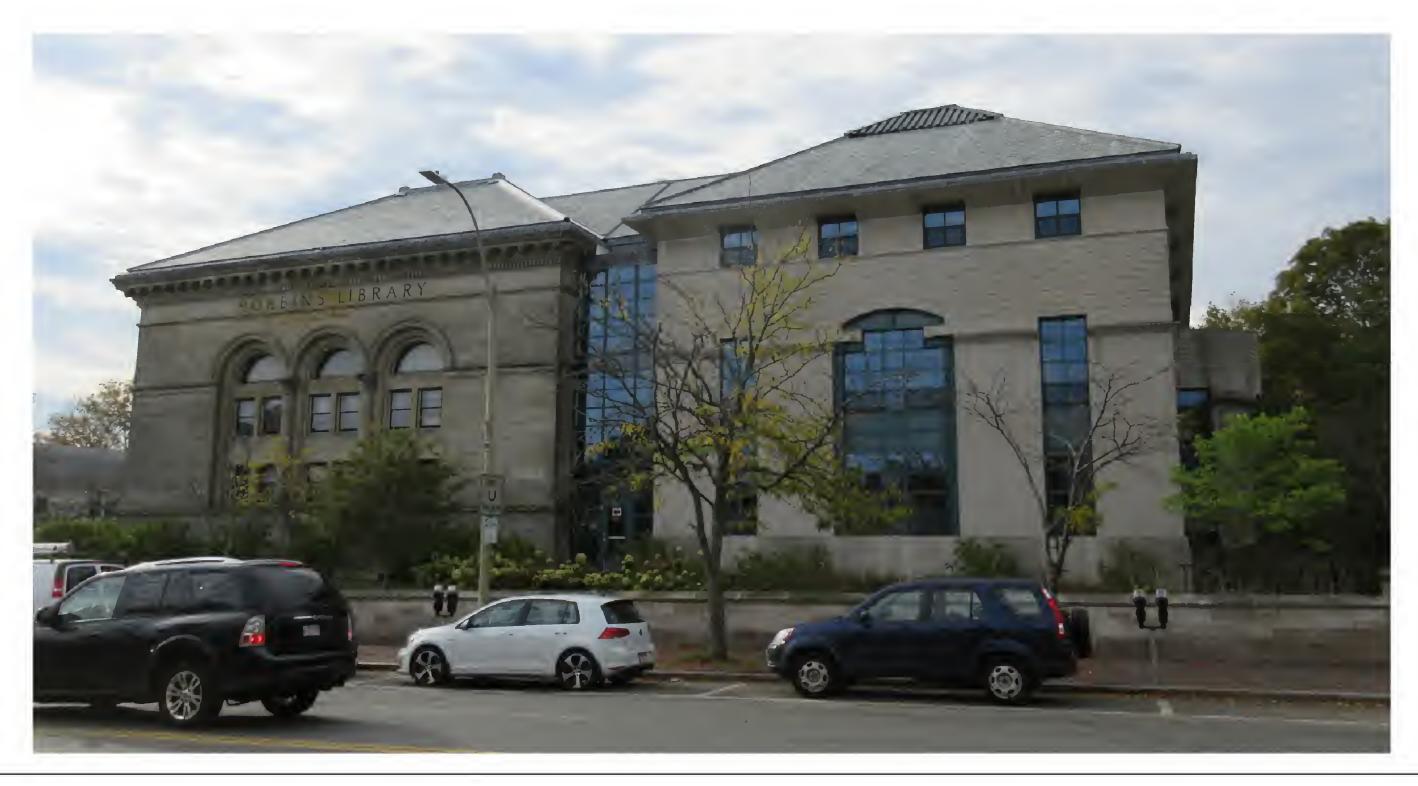

NOTE:
CONTRACTOR TO FIELD VERIFY ALL DIMENSIONS AND CONDITIONS.



DRAWING SHEETS:

GENERAL G0-01 COVER SHEET

<u>LANDSCAPE</u> L1-01 EXISTING SITE PLAN

ARCHITECTURAL

A2-01 EAST EXTERIOR ELEVATION A2-02 SOUTH EXTERIOR ELEVATION A2-03 WEST EXTERIOR ELEVATION

A2-04 NORTH EXTERIOR ELEVATION A4-01 REPAIR & RESTORATION DETAILS

### **GENERAL NOTES:**

- ADDITIONAL INSUREDS TO THE CONTRACTOR'S COMMERCIAL GENERAL LIABILITY, THE CONTRACTOR'S INSURERS SHALL PROVIDE A WAIVER OF SUBROGATION IN FAVOR OF THE TOWN OF ARLINGTON AND CBI CONSULTING INC.
- CONTRACTOR SHALL BE RESPONSIBLE FOR CHECKING AND COORDINATING ALL DIMENSIONS WITH ARCHITECTURAL DRAWINGS. IN CASE OF CONFLICT, THE ARCHITECT SHALL BE NOTIFIED AND SHALL RESOLVE THE CONFLICT. THE CONTRACTOR SHALL FIELD VERIFY ALL DIMENSIONS AND CONDITIONS.
- IN ANY CASE OF CONFLICT BETWEEN OR WITHIN THE DRAWINGS AND THE PROJECT SPECIFICATIONS OR WITHIN THE DRAWINGS OR SPECIFICATIONS, THE MORE STRINGENT REQUIREMENTS SHALL GOVERN AT THE SOLE DISCRETION OF
- G3 THE CONTRACTOR SHALL MAKE NO DEVIATION FROM DESIGN DRAWINGS WITHOUT PRIOR REVIEW BY THE ARCHITECT.
- WORK NOT INDICATED ON A PART OF THE DRAWINGS BUT REASONABLY IMPLIED REPEATED. ANY CONDITION FOUND NOT DETAILED SHALL BE CONSTRUCTED IN A MANNER SIMILAR TO THAT OF THE TYPICAL DETAILS.
- G5 ALL WORK SHALL COMPLY WITH APPLICABLE CODES AND LOCAL LAWS AND
- GENERAL CONTRACTOR SHALL COORDINATE LOCATIONS OF OPENINGS, PITS, BOXES, SUMPS, TRENCHES, SLEEVES, DEPRESSIONS, GROOVES, AND
- THE STRUCTURAL DESIGN OF THE BUILDING IS BASED ON THE FULL INTERACTION OF ALL ITS COMPONENT PARTS. NO PROVISIONS HAVE BEEN MADE FOR CONDITIONS OCCURRING DURING CONSTRUCTION. IT IS THE SOLE RESPONSIBILITY OF THE CONTRACTOR TO MAKE PROPER AND ADEQUATE PROVISIONS FOR STABILITY OF, AND ALL STRESSES TO, THE STRUCTURE DUE TO ANY CAUSE DURING CONSTRUCTION.
- CONTRACTOR SHALL NOT SCALE DRAWINGS. CONTRACTOR SHALL REQUEST THE ARCHITECT. WORK COMPLETED BY THE CONTRACTOR WITHOUT DIMENSIONS OR INFORMATION SHALL BE DONE AT HIS OWN RISK AND SHALL BE REMOVED AND REINSTALLED TO THE SPECIFICATIONS OF THE ARCHITECT AT NO
- MEANS AND METHODS OF CONSTRUCTION AS WELL AS COMPLIANCE WITH OSHA AND OTHER SAFETY LAWS AND REGULATIONS IS EXCLUSIVE RESPONSIBILITY OF THE CONTRACTOR, HIS SUBCONTRACTOR(S), SUPPLIERS, CONSULTANTS AND
- G10 FOR ALL ITEMS THAT ARE TO BE REUSED AND/OR REINSTALLED AS PART OF THE ALL ITEMS THAT ARE TO REMAIN ARE TO BE PROTECTED FROM DAMAGE. IF ANY DAMAGE OCCURS THE CONTRACTOR SHALL REPAIR THE ITEM SO IT

FUNCTIONS THE SAME OR BETTER THAN THE ORIGINAL ITEM.

IS IN A LIKE NEW CONDITION OR REPLACE IT WITH A NEW ITEM THAT

TRANSPORT THE ITEM BACK TO ITS ORIGINAL LOCATION AND CAREFULLY REINSTALL. IF ANY DAMAGE OCCURS THE CONTRACTOR SHALL REPAIR THE ITEM SO IT IS IN A LIKE NEW CONDITION OR REPLACE IT WITH A NEW ITEM THAT FUNCTIONS THE SAME OR BETTER THAN THE ORIGINAL ITEM.

# LIST OF ABBREVIATIONS

LIST	OI ADDINEVIATIONS	
F.F.	ABOVE FINISH FLOOR	CONTACT INFORMATION:
PPROX.	APPROXIMATE	
IT.	BITUMINOUS	A ala:4 a a4
UR	BUILT UP ROOFING	Architect
В	CATCH BASIN	
MU	CONCRETE MASONRY UNIT	CBI CONSULTING, L
ONC.	CONCRETE	C D I C O N 3 O L I I N G, L
ONT.	CONTINUOUS	
.S.	DOWNSPOUT	
Q	EQUAL	
W.	EACH WAY	
)	FLOOR DRAIN	
D C T	HANDICAP	
Т	HEIGHT	
N	INVERT IN	
OUT	INVERT OUT	
)	INTERIOR DIAMETER	
C.C.	LEAD COATED COPPER	
AX.	MAXIMUM	
IIN.	MINIMUM	
l.O.	MASONRY OPENING	www.cbiconsultingllc.com
/ <b>A</b>	NOT APPLICABLE	www.cbiconsuitingiic.com
l.I.C.	NOT IN CONTRACT	
l.T.S.	NOT TO SCALE	250 DODGUECTED AVEN
).C.	ON CENTER	250 DORCHESTER AVEN
D	OVERHEAD DOOR	BOSTON, MA 02127
).H.	OPPOSITE HAND	DOSTON, ITA OZIZI
AV.	PAVERS	
Т.	PRESSURE TREATED	D ((17) 2(0 0077
M.	SIMILAR TO	P: (617) 268-8977
S.	STAINLESS STEEL	F: (617) 464-2971
	TREAD	] 1. (017) 404-2771
YP.	TYPICAL	
.O.N.	UNLESS OTHERWISE NOTED	
.l.F.	VERIFY IN FIELD	cbi@cbiconsultingllc.co
СВ	VINYL COVE BASE	www.cbiconsultingllc.co
<b>V</b> /	WITH	

# ZINC COATED COPPER DIAMETER PLUS OR MINUS SYMBOL LEGEND

88 AX-XX	SEE DETAIL 88 ON SHEET AX-XX
	BREAK LINE
*	DIMENSION LINE
<b>-</b>	EXTENT

**DOOR TAG** 

WINDOW TAG

Z.C.C.

Fax: (781) 389-7891



ORCHESTER AVENUE ON, MA 02127

cbiconsultingllc.com cbiconsultingllc.com

## Owner

Fergal O'Brien Superintendent Of Building Maintainance TOWN OF ARLINGTON Phone: (781) 389-7891 Email: fobrien@town.arlington.ma.us

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# **ROBBINS LIBRARY** TOWN OF **ARLINGTON**

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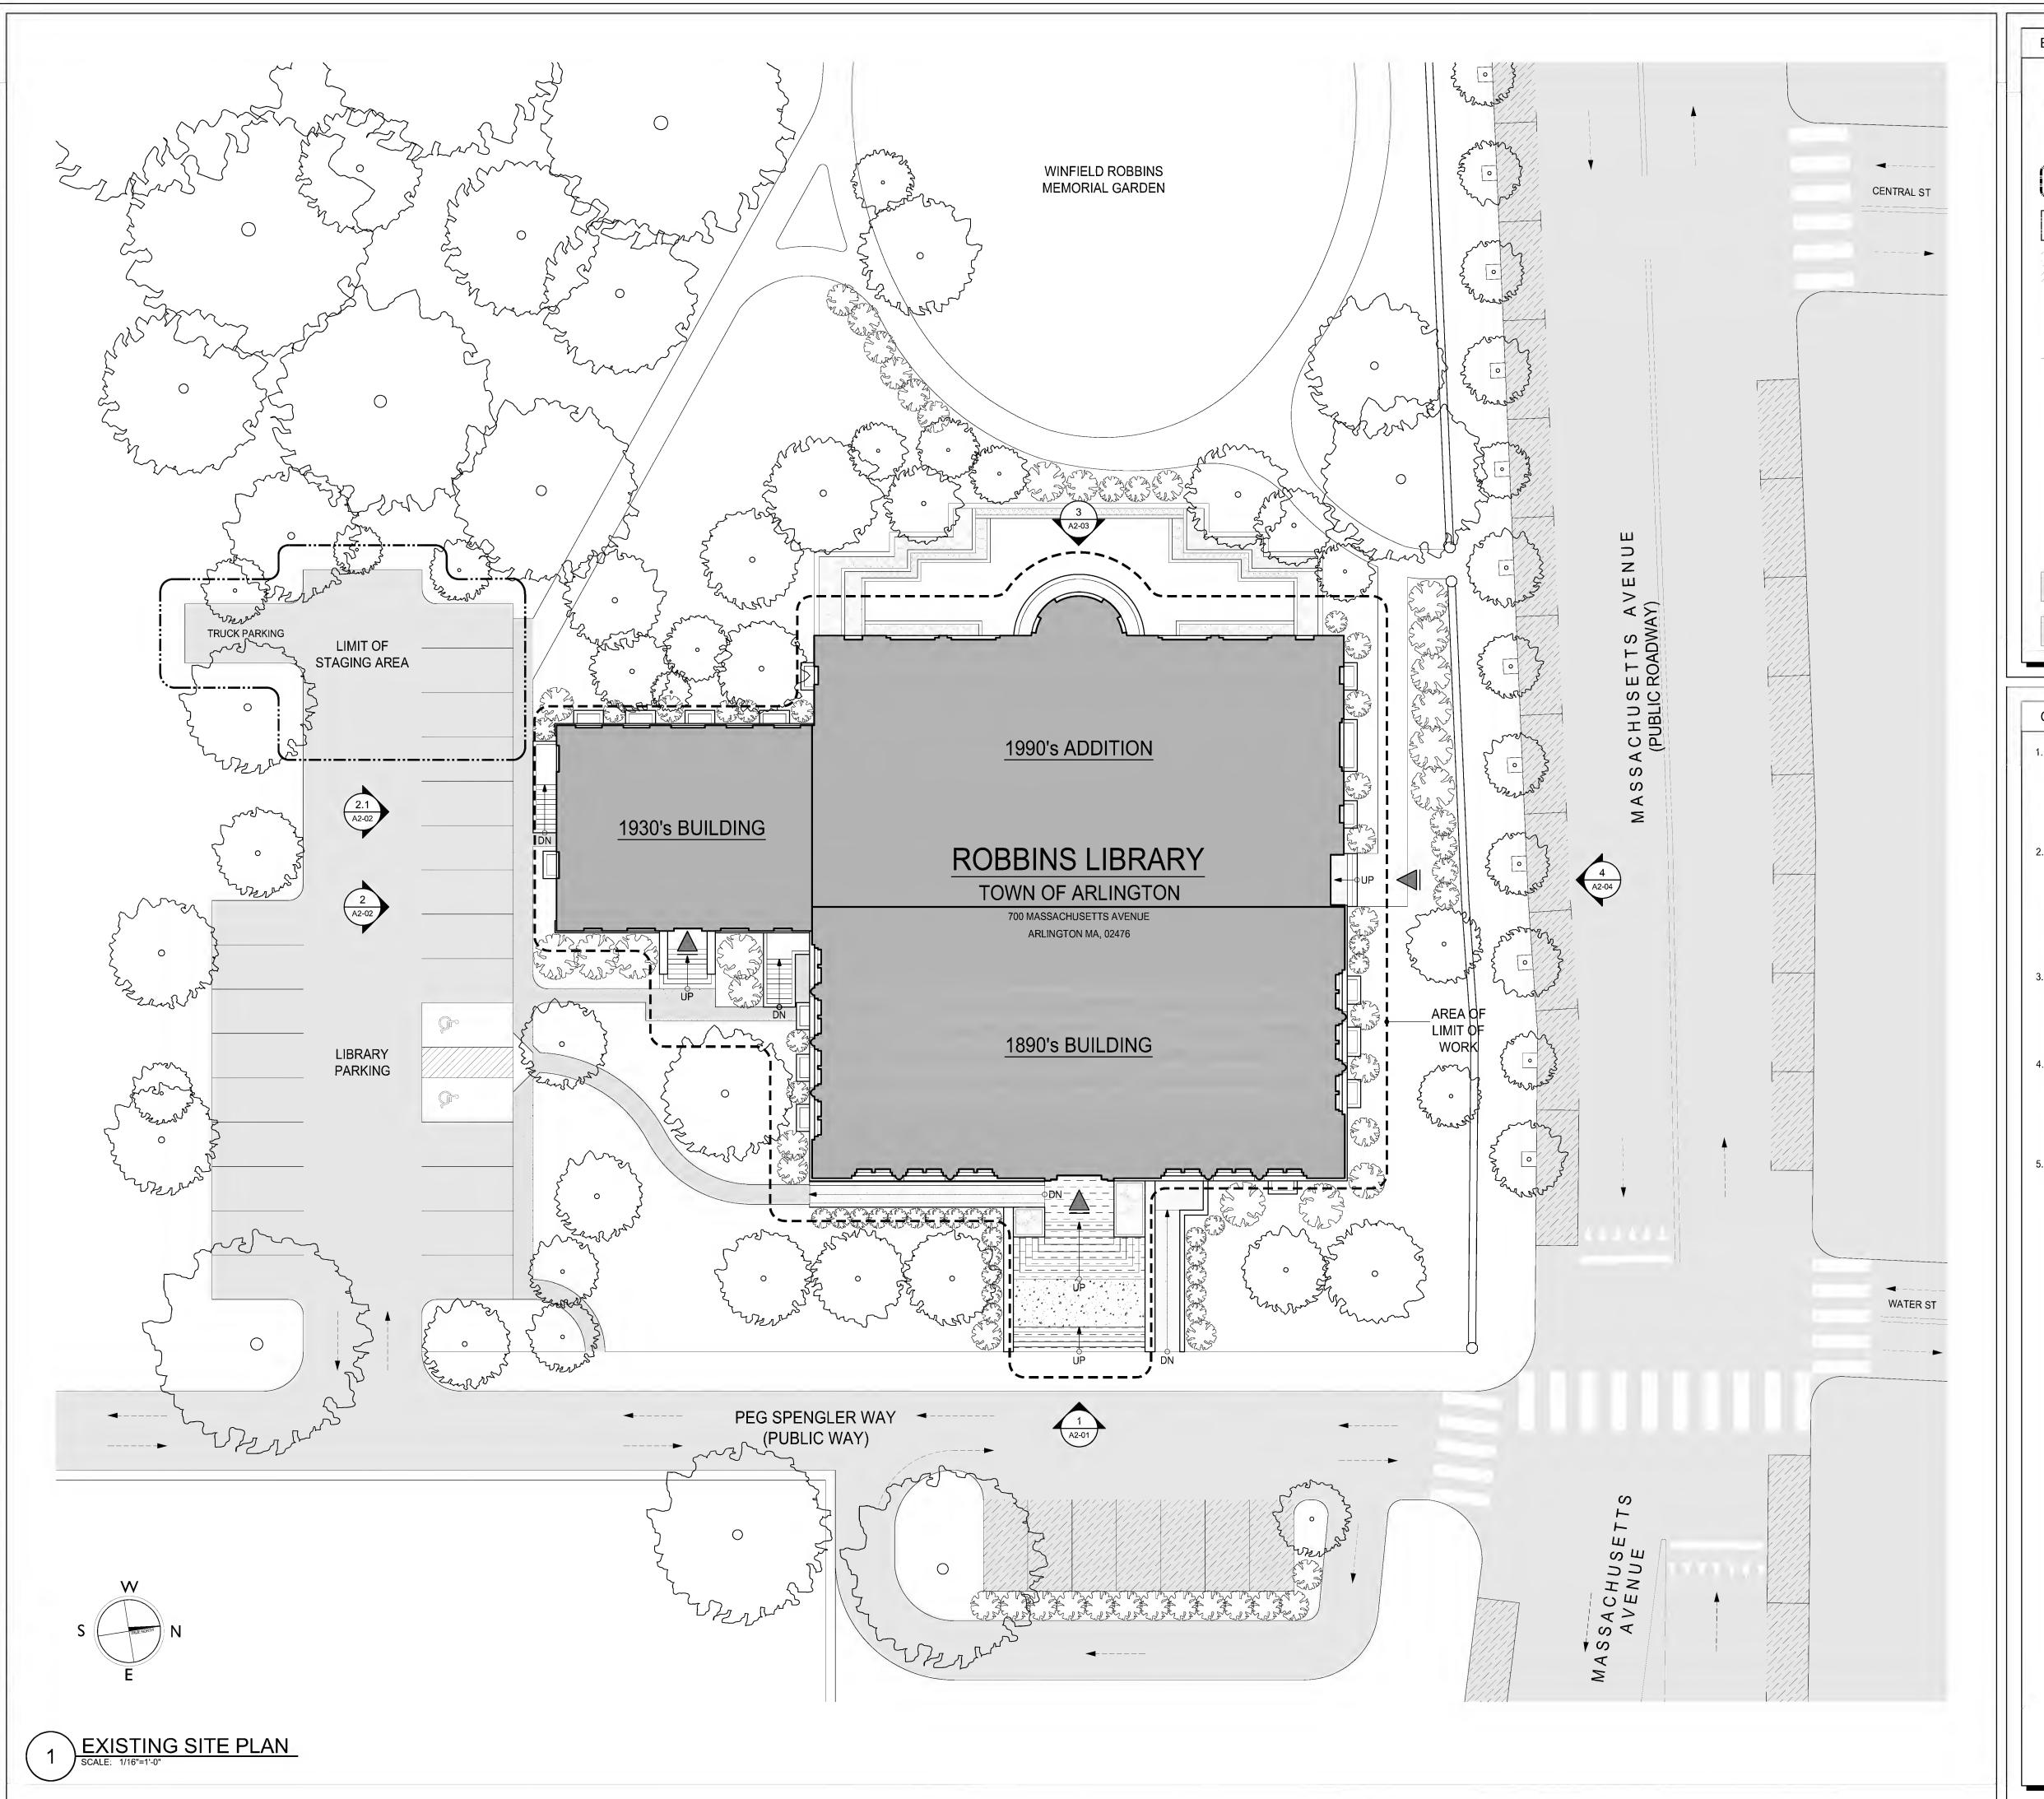
**EXTERIOR ENVELOPE REPAIRS** -PHASE IA BID NO. 19-58




Drawing Title:

**COVER SHEET** 

BID **DOCUMENTS** 



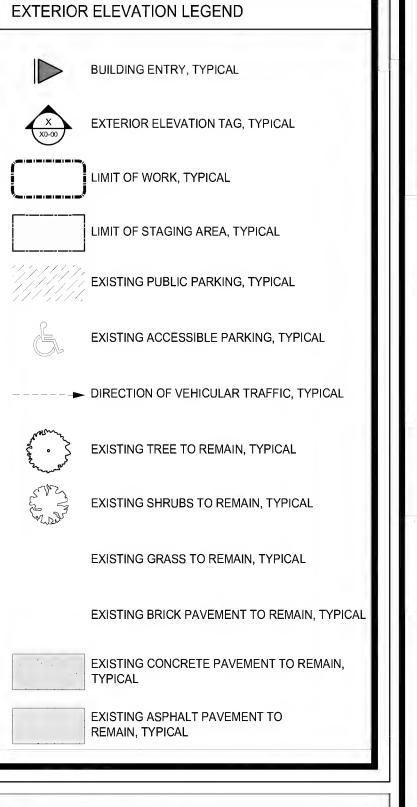

### GENERAL SITE NOTES:

- 1. PROTECT ALL EXISTING GRASS, SHRUBS AND TREES WITHIN AND IN PROXIMITY TO THE LIMIT OF WORK AREA INCLUDING, CONTRACTOR'S STORAGE, LAY-DOWN AND FENCED AREAS. DO NOT OPERATE MACHINERY UNDERNEATH TREE CANOPIES, TYPICAL. REPAIR OR REPLACE ALL DAMAGED AREAS TO THE SATISFACTION OF THE OWNER.
- 2. THE BUILDING WILL BE OCCUPIED DURING
  CONSTRUCTION AND ALL EXITS AND ENTRANCES SHALL
  BE MAINTAINED CLEAR, CLEAN AND SAFE. PROVIDE
  TEMPORARY ENCLOSURES TO PROTECT THE BUILDING
  OCCUPANTS FROM THE WORK AND PROVIDE
  TEMPORARY DIRECTIONAL SIGNAGE FOR THE PUBLIC
  INSIDE AND OUTSIDE THE BUILDING. ALL SIDEWALKS, ALL
  CORRIDORS AND ALL STAIRS MUST REMAIN OPEN AND
  ACCESSIBLE AT ALL TIMES.
- 3. SMOKING AND FOUL LANGUAGE IS STRICTLY PROHIBITED ON THE PROPERTY. WORKERS WHO ARE CAUGHT SMOKING OR USING FOUL LANGUAGE MAY BE PROHIBITED FROM RETURNING TO THE SITE FOR THE DURATION OF THE PROJECT AT THE SOLE DISCRETION OF THE OWNER.
- 4. CONTRACTOR TO PROVIDE A SITE UTILIZATION PLAN SHOWING FINAL FENCING, PROTECTION, STAGING, DUMPSTER, STORAGE, ETC... FOR OWNER AND ARCHITECT'S APPROVAL PRIOR TO MOBILIZATION. LOCATIONS SHALL MINIMIZE DISRUPTIONS TO THE LIBRARY SCHEDULE, THE BUILDING AND THE SURROUNDING TO FULLEST EXTENT POSSIBLE.
- 5. CONTRACTOR STORAGE AND LAY-DOWN AREA TO BE LIMITED TO THE AREA BETWEEN THE CONTRACTORS FENCE AND THE BUILDING ON THE SOUTH AND EAST SIDES OF THE BUILDING.



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EXTERIOR ENVELOPE REPAIRS -PHASE IA BID NO. 19-58



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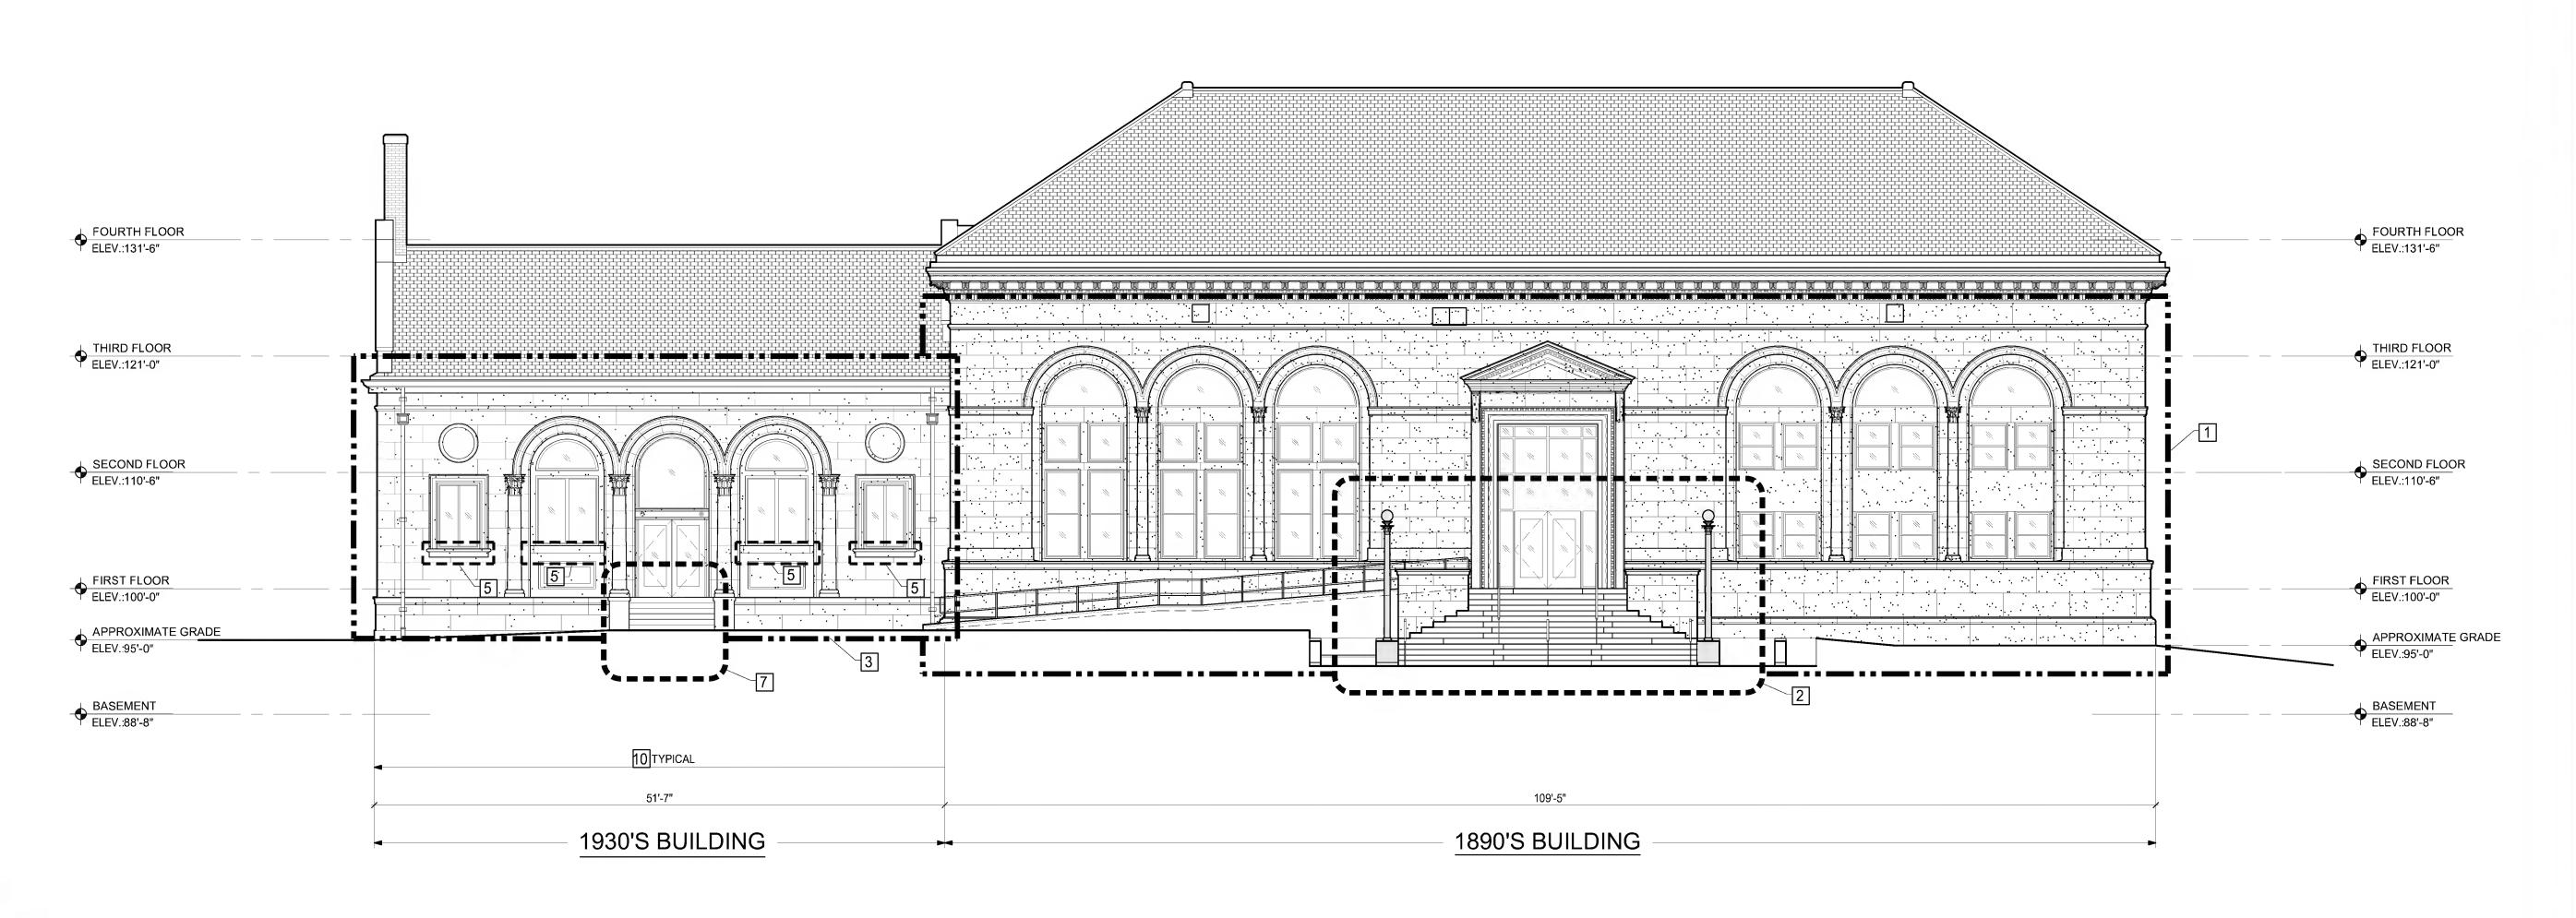
EXISTING SITE PLAN

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BID DOCUMENTS


Date: 11/07/20
Project Number: 1715
Project Manager: A
Drawn By: LY/BI
Scale: 1/16"=1

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#### REPAIR AND RESTORATION WORK NOTES: 7. CUT OUT AND DISPOSE SPALLS, CHIPS AND DELAMINATION IN THE ARCHITECTURAL CAST IN PLACE STONE EXIT ROUTE AND CLEAN EXISTING CRACKS IN ANY SANDSTONE (1890'S BUILDING) DETAIL OR ELEMENT, AND FILL CRACKS WITH INJECTION RESTORATION REPAIR MORTAR. TOTAL QUANTITY OF 50 LINEAL FEET IN SELECT STAIRS OF THE 1930'S BUILDING. CUT OUT A MINIMUM 1" DEEP & SQUARE OFF ALL EDGES. CLEAN SURFACE & AND RANDOM LOCATIONS ACROSS ALL ELEVATIONS AS SELECTED BY ARCHITECT. REFER TO UNIT PRICES -APPLY SINGLE COMPONENT, CEMENTITIOUS MINERAL BASED REPAIR MORTAR. SPECIFICATION 01 22 00. 2. REPLACE EXISTING SEALANT AND MORTAR JOINTS OF THE EXTERIOR GRANITE STONE STAIRS AT MAIN ENTRANCE OF THE 1890'S LIBRARY BUILDING. CUT, REMOVE AND DISPOSE OF 100% ALL EXISTING VERTICAL 8. REPLACE EXISTING SEALANT AND MORTAR JOINTS AT THE EXIT STAIRS OF THE 1930'S BUILDING. CUT, REMOVE AND DISPOSE OF 100% ALL EXISTING VERTICAL AND HORIZONTAL JOINT SEALANTS, INCLUDING UNDERLYING AND HORIZONTAL JOINT SEALANTS, INCLUDING UNDERLYING MORTAR A MINIMUM OF 1-1/2-INCHES OR UNTIL MORTAR A MINIMUM OF 1-1/2-INCHES OR UNTIL SOUND MORTAR FROM ALL ARCHITECTURAL CAST IN PLACE SOUND MORTAR FROM ALL GRANITE STONE STAIRS. APPLY NEW POINTING MORTAR TO WITHIN 1/2-INCH OF STONE STAIRS AND LANDING. APPLY NEW POINTING MORTAR TO WITHIN 1/2-INCH OF THE SURFACE AND APPLY THE SURFACE AND APPLY POLYURETHANE SEALANT TO ALL GRANITE STONE JOINTS. STAIRS SHALL BE POLYURETHANE SEALANT TO ALL CAST IN PLACE STONE STAIRS AND LANDING JOINTS. STAIRS SHALL BE POWER POWER WASHED CLEANED. SEE ENLARGE PLAN 1/ A401 AND DETAIL 5a & 5b / A4-01. WASHED CLEANED. SEE DETAIL 3 & 4 / A4-01. ROUTE AND CLEAN EXISTING CRACKS IN ANY ARCHITECTURAL CAST STONE ( 1930S BUILDING ) DETAIL OR ELEMENT, AND FILL CRACKS WITH INJECTION RESTORATION REPAIR MORTAR. TOTAL QUANTITY OF 25 LINEAL FEET IN SELECT AND RANDOM LOCATIONS ACROSS ALL ELEVATION SELECTED BY THE ARCHITECT. SEE DETAIL DEDUCT ALTERNATES: 1. DEDUCT ALTERNATE NO.1 – ELIMINATE ALL REPAIR WORK ASSOCIATED WITH THE ENTRY/EXIT STAIRS OF THE 1a & 1b/ A4-01. REFER TO UNIT PRICE - SPECIFICATION 01 22 00. 1930'S BUILDING, INCLUDING REPLACING EXISTING SEALANT AND MORTAR JOINTS, ALL AS INCLUDED IN NOTES 7 AND 8. REMOVE AND DISPOSE OF EXISTING ARCHITECTURAL CAST STONE WINDOW HEAD IN TWO (2) LOCATIONS AS SELECTED BY THE ARCHITECT. TEMPORARILY SHORE AND SUPPORT OPENING, FABRICATE AND INSTALL NEW 2. DEDUCT ALTERNATE NO.2 - ELIMINATE ALL WORK ASSOCIATED TO RESEAL THE EXISTING ALUMINUM SPANDREL PANELS FOR THE 1990'S BUILDING, ALL AS INCLUDED IN NOTE 6. REINFORCED ARCHITECTURAL PRECAST HEADER TO MATCH SIZE, TEXTURE, AND COLOR. SEE DETAIL 9A/ A4-01. REFER TO UNIT PRICE - SPECIFICATION 01 22 00 AND DEDUCT ALTERNATE NO. 3 3. DEDUCT ALTERNATE NO.3 – ELIMINATE TWO (2) LOCATIONS OF WORK ASSOCIATED WITH REPLACING ARCHITECTURAL CAST STONE WINDOW HEAD, ALL AS INCLUDED IN NOTE 4. CUT OUT AND DISPOSE SPALLS, CHIPS AND DELAMINATIONS IN THE ARCHITECTURAL CAST STONE WINDOW SILL. CUT OUT A MINIMUM 1/2" DEEP & SQUARE OFF ALL EDGES. CLEAN SURFACE & APPLY SINGLE COMPONENT, CEMENTITIOUS MINERAL BASED REPAIR MORTAR TOTAL QUANTITY OF 208 CUBIC INCHES IN SELECT AND RANDOM LOCATIONS ACROSS ALL ELEVATION SELECTED BY THE ARCHITECT. REFER TO UNIT PRICE - SPECIFICATION 01 22 00. 6. RE-SEAL EXISTING ALUMINUM SPANDREL PANELS, AND GLASS PANELS AS IDENTIFIED AT 1990'S BUILDING. SEE DETAIL 8a & 8b / A4-01 CUT, REMOVE & DISPOSE OF EXISTING RUBBER GASKETS FLUSH WITH PANEL FRAME. SEE DETAIL8a/ A4-01 APPLY NEW BACKER ROD WHERE GASKETS ARE MISSING BETWEEN THE PANEL AND FRAME. CLEAN AND PRIME SURFACES AND APPLY NON-SAG SINGLE COMPONENT SILICONE SEALANT. COLOR TO BE SELECTED BY ARCHITECT FROM FULL RANGE OF CUSTOM COLORS. REFER TO DEDUCT ALTERNATE NO. 2.



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EXTERIOR ENVELOPE REPAIRS -PHASE I A BID NO. 19-58

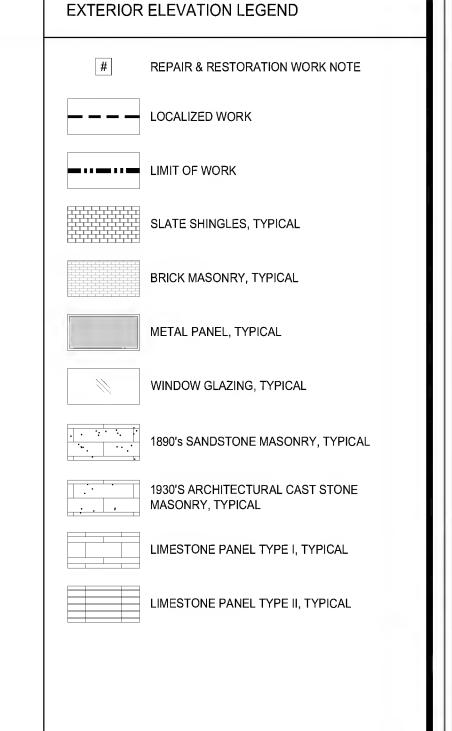

Drawing Title:

EAST EXTERIOR ELEVATIONS


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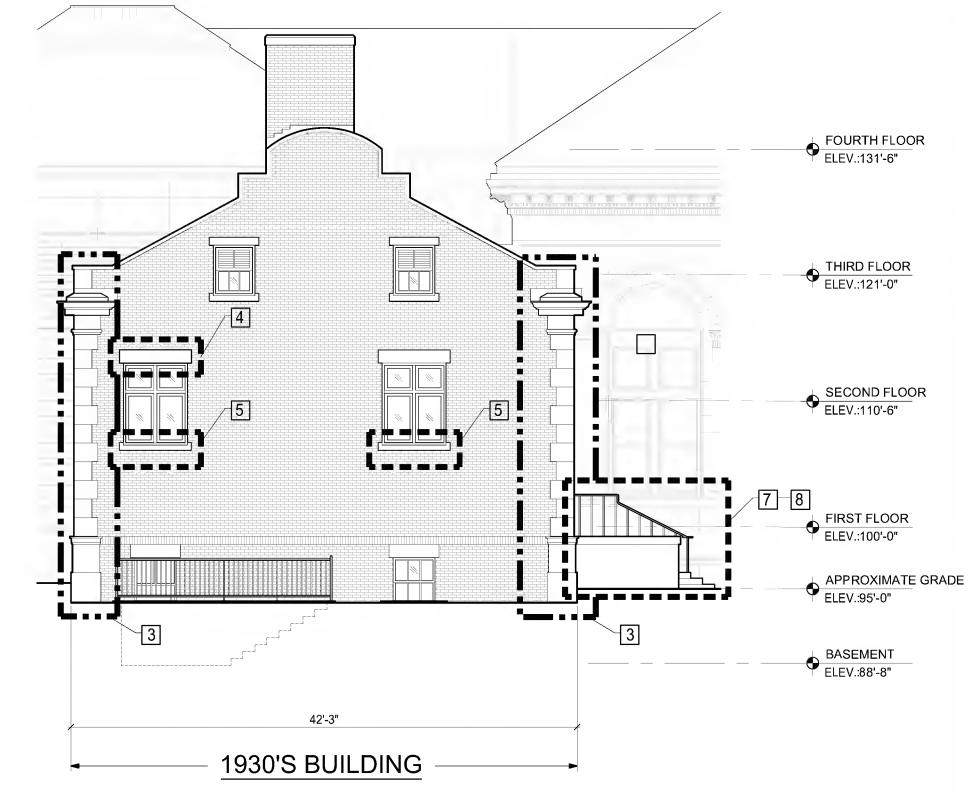
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**DOCUMENTS** 

Date: I1/07/2019
Project Number: I7152-A
Project Manager: ALS
Drawn By: LY/BDO
Scale: I/8"=1'-0"

A2-01



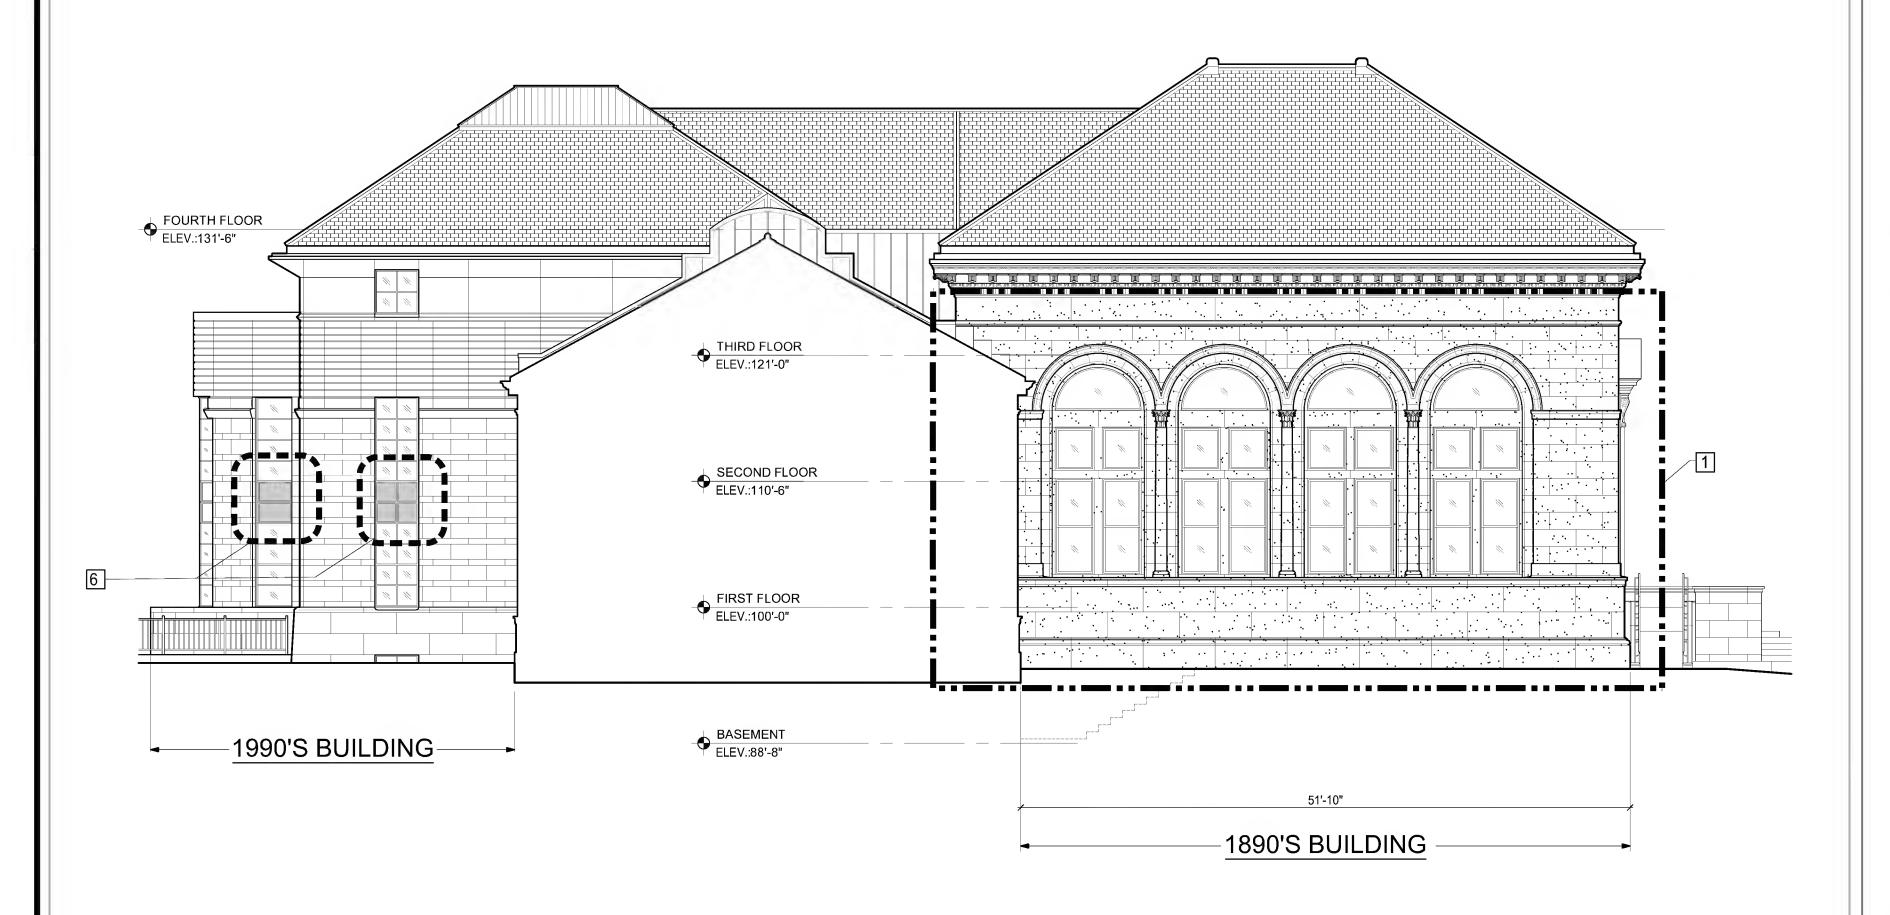

2 SOUTH EXTERIOR ELEVATION
SCALE: 1/8"=1'-0"

PARTIAL SOUTH EXTERIOR ELEVATION
SCALE: 1/8"=1'-0"

### REPAIR AND RESTORATION WORK NOTES:

- ROUTE AND CLEAN EXISTING CRACKS IN ANY SANDSTONE (1890'S BUILDING) DETAIL OR ELEMENT, AND FILL CRACKS WITH INJECTION RESTORATION REPAIR MORTAR. TOTAL QUANTITY OF 50 LINEAL FEET IN SELECT AND RANDOM LOCATIONS ACROSS ALL ELEVATIONS AS SELECTED BY ARCHITECT. REFER TO UNIT PRICES SPECIFICATION 01 22 00.
- 2. REPLACE EXISTING SEALANT AND MORTAR JOINTS OF THE EXTERIOR GRANITE STONE STAIRS AT MAIN ENTRANCE OF THE 1890'S LIBRARY BUILDING. CUT, REMOVE AND DISPOSE OF 100% ALL EXISTING VERTICAL AND HORIZONTAL JOINT SEALANTS, INCLUDING UNDERLYING MORTAR A MINIMUM OF 1-1/2-INCHES OR UNTIL SOUND MORTAR FROM ALL GRANITE STONE STAIRS. APPLY NEW POINTING MORTAR TO WITHIN 1/2-INCH OF THE SURFACE AND APPLY POLYURETHANE SEALANT TO ALL GRANITE STONE JOINTS. STAIRS SHALL BE POWER WASHED CLEANED. SEE ENLARGE PLAN 1/ A401 AND DETAIL 5a & 5b / A4-01.
- ROUTE AND CLEAN EXISTING CRACKS IN ANY ARCHITECTURAL CAST STONE (1930S BUILDING) DETAIL OR ELEMENT, AND FILL CRACKS WITH INJECTION RESTORATION REPAIR MORTAR. TOTAL QUANTITY OF <u>25 LINEAL FEET</u> IN SELECT AND RANDOM LOCATIONS ACROSS ALL ELEVATION SELECTED BY THE ARCHITECT. SEE DETAIL 1a & 1b/ A4-01. REFER TO UNIT PRICE SPECIFICATION 01 22 00.
- REMOVE AND DISPOSE OF EXISTING ARCHITECTURAL CAST STONE WINDOW HEAD IN TWO (2) LOCATIONS AS SELECTED BY THE ARCHITECT. TEMPORARILY SHORE AND SUPPORT OPENING, FABRICATE AND INSTALL NEW REINFORCED ARCHITECTURAL PRECAST HEADER TO MATCH SIZE, TEXTURE, AND COLOR. SEE DETAIL 9A/ A4-01. REFER TO UNIT PRICE SPECIFICATION 01 22 00 AND DEDUCT ALTERNATE NO. 3
- CUT OUT AND DISPOSE SPALLS, CHIPS AND DELAMINATIONS IN THE ARCHITECTURAL CAST STONE WINDOW SILL. CUT OUT A MINIMUM 1/2" DEEP & SQUARE OFF ALL EDGES. CLEAN SURFACE & APPLY SINGLE COMPONENT, CEMENTITIOUS MINERAL BASED REPAIR MORTAR TOTAL QUANTITY OF 208 CUBIC INCHES IN SELECT AND RANDOM LOCATIONS ACROSS ALL ELEVATION SELECTED BY THE ARCHITECT. REFER TO UNIT PRICE SPECIFICATION 01 22 00.
- 6. RE-SEAL EXISTING ALUMINUM SPANDREL PANELS, AND GLASS PANELS AS IDENTIFIED AT 1990'S BUILDING. SEE DETAIL 8a & 8b / A4-01
  - a. CUT, REMOVE & DISPOSE OF EXISTING RUBBER GASKETS FLUSH WITH PANEL FRAME. SEE DETAIL8a/ A4-01 b. APPLY NEW BACKER ROD WHERE GASKETS ARE MISSING BETWEEN THE PANEL AND FRAME.
  - CLEAN AND PRIME SURFACES AND APPLY NON-SAG SINGLE COMPONENT SILICONE SEALANT. COLOR TO BE SELECTED BY ARCHITECT FROM FULL RANGE OF CUSTOM COLORS.
  - d. REFER TO DEDUCT ALTERNATE NO. 2.

- 7. CUT OUT AND DISPOSE SPALLS, CHIPS AND DELAMINATION IN THE ARCHITECTURAL CAST IN PLACE STONE EXIT STAIRS OF THE 1930'S BUILDING. CUT OUT A MINIMUM 1" DEEP & SQUARE OFF ALL EDGES. CLEAN SURFACE & APPLY SINGLE COMPONENT, CEMENTITIOUS MINERAL BASED REPAIR MORTAR.
- 8. REPLACE EXISTING SEALANT AND MORTAR JOINTS AT THE EXIT STAIRS OF THE 1930'S BUILDING. CUT, REMOVE AND DISPOSE OF 100% ALL EXISTING VERTICAL AND HORIZONTAL JOINT SEALANTS, INCLUDING UNDERLYING MORTAR A MINIMUM OF 1-1/2-INCHES OR UNTIL SOUND MORTAR FROM ALL ARCHITECTURAL CAST IN PLACE STONE STAIRS AND LANDING. APPLY NEW POINTING MORTAR TO WITHIN 1/2-INCH OF THE SURFACE AND APPLY POLYURETHANE SEALANT TO ALL CAST IN PLACE STONE STAIRS AND LANDING JOINTS. STAIRS SHALL BE POWER WASHED CLEANED. SEE DETAIL 3 & 4 / A4-01.

### DEDUCT ALTERNATES:

- 1. DEDUCT ALTERNATE NO.1 ELIMINATE ALL REPAIR WORK ASSOCIATED WITH THE ENTRY/EXIT STAIRS OF THE 1930'S BUILDING, INCLUDING REPLACING EXISTING SEALANT AND MORTAR JOINTS, ALL AS INCLUDED IN NOTES 7 AND 8.
- 2. DEDUCT ALTERNATE NO.2 ELIMINATE ALL WORK ASSOCIATED TO RESEAL THE EXISTING ALUMINUM SPANDREL PANELS FOR THE 1990'S BUILDING, ALL AS INCLUDED IN NOTE 6.
- 3. DEDUCT ALTERNATE NO.3 ELIMINATE TWO (2) LOCATIONS OF WORK ASSOCIATED WITH REPLACING ARCHITECTURAL CAST STONE WINDOW HEAD, ALL AS INCLUDED IN NOTE 4.

# REPAIR & RESTORATION WORK NOTE

LOCALIZED WORK

LIMIT OF WORK

SLATE SHINGLES, TYPICAL

BRICK MASONRY, TYPICAL

WINDOW GLAZING, TYPICAL

1890'S SANDSTONE MASONRY, TYPICAL

1930'S ARCHITECTURAL CAST STONE MASONRY, TYPICAL

LIMESTONE PANEL TYPE I, TYPICAL

LIMESTONE PANEL TYPE II, TYPICAL

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Drawing Title:

SOUTH EXTERIOR ELEVATIONS


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<u>.</u>\*.......

BID DOCUMENTS

Date: | 11/07/2019
Project Number: | 17152-A
Project Manager: ALS
Drawn By: LY/BDO
Scale: | 1/8"=1'-0"

A2-02

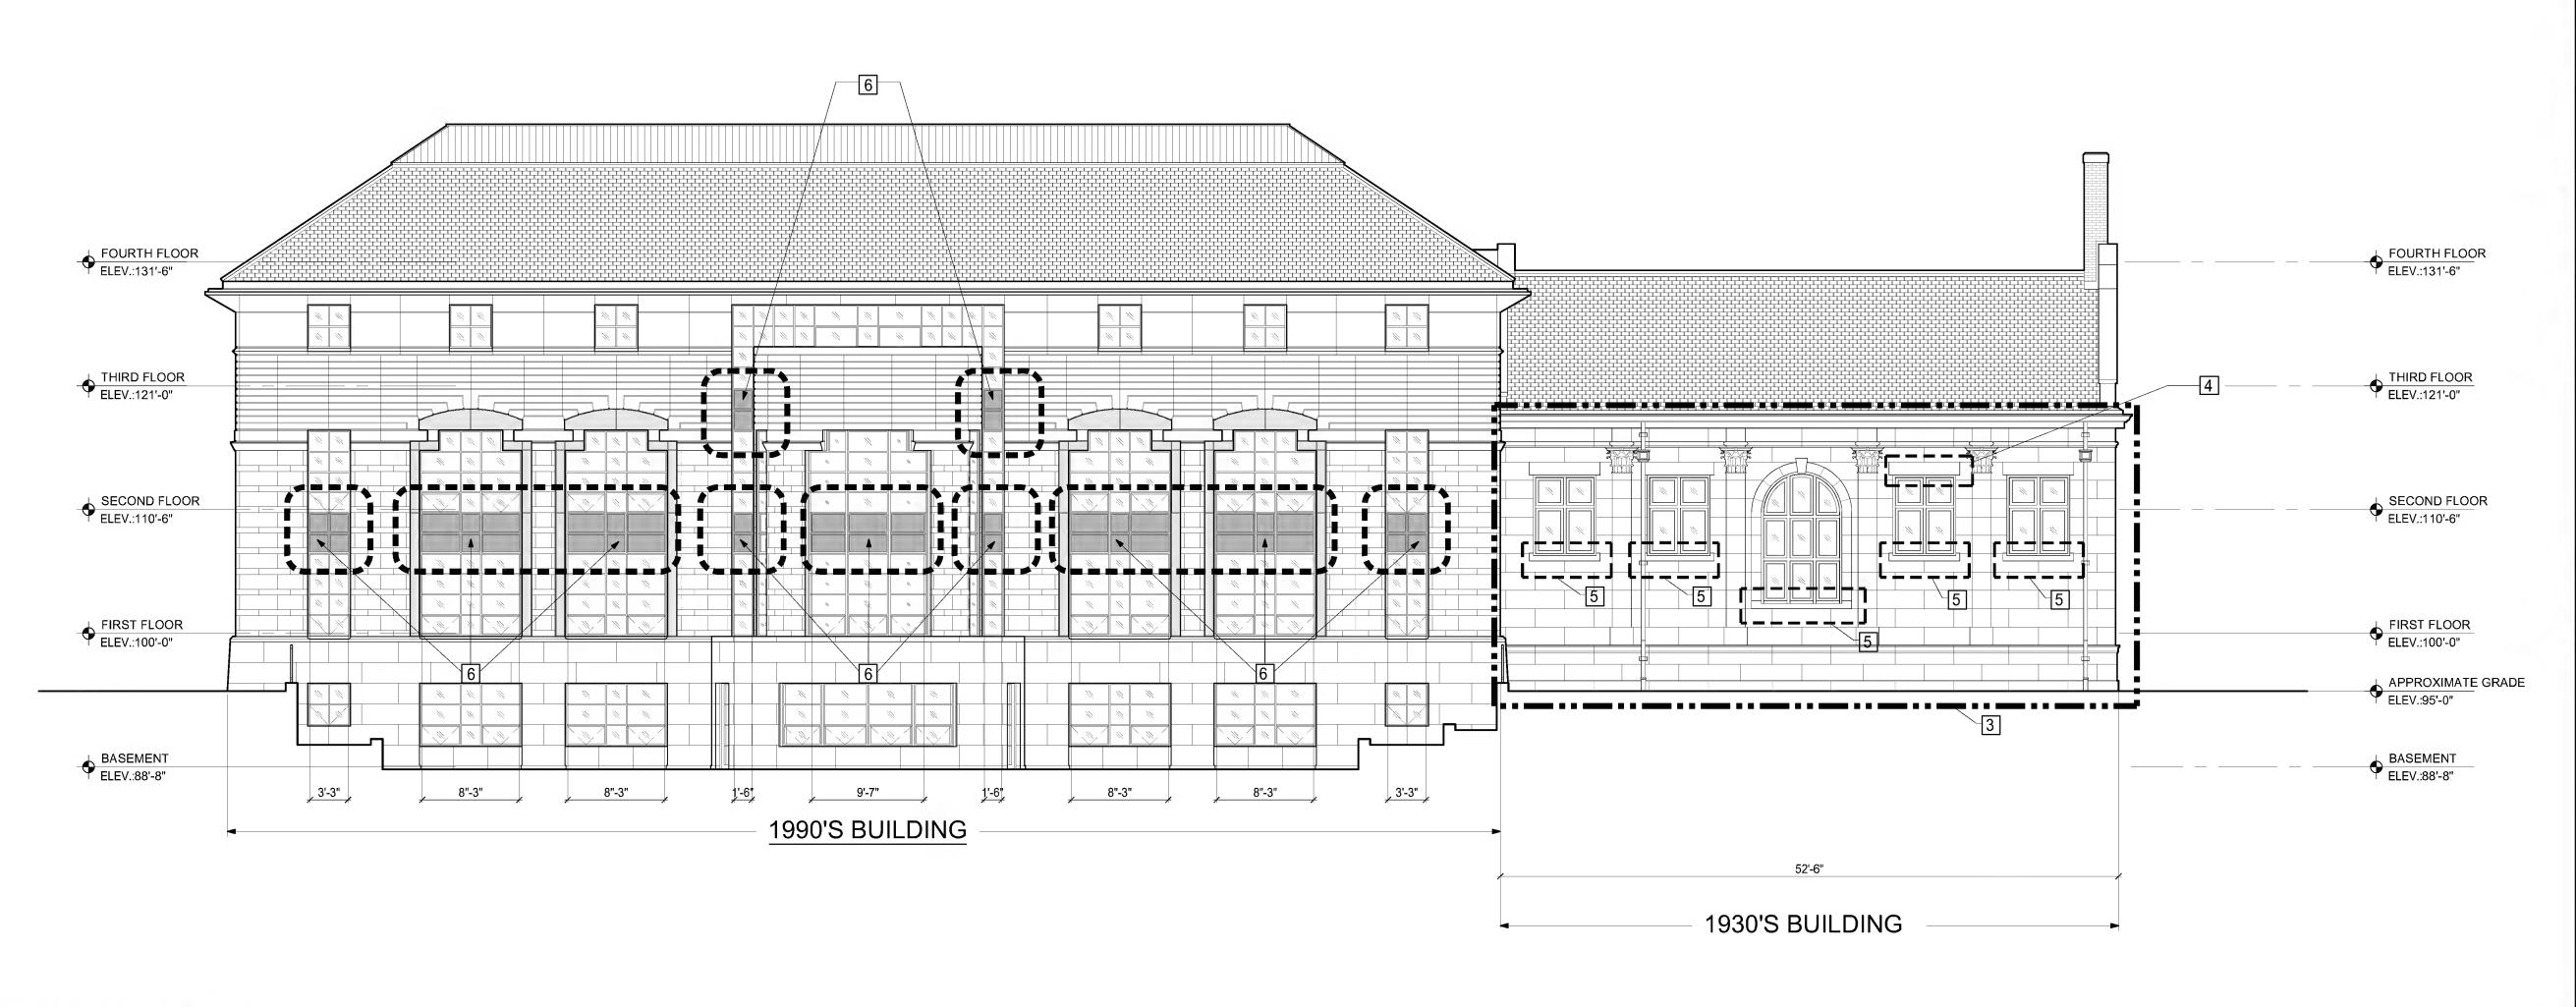

# 3 WEST EXTERIOR ELEVATION SCALE: 1/8"=1'-0"


## REPAIR AND RESTORATION WORK NOTES:

- ROUTE AND CLEAN EXISTING CRACKS IN ANY SANDSTONE (1890'S BUILDING) DETAIL OR ELEMENT, AND FILL CRACKS WITH INJECTION RESTORATION REPAIR MORTAR. TOTAL QUANTITY OF 50 LINEAL FEET IN SELECT AND RANDOM LOCATIONS ACROSS ALL ELEVATIONS AS SELECTED BY ARCHITECT. REFER TO UNIT PRICES SPECIFICATION 01 22 00.
- REPLACE EXISTING SEALANT AND MORTAR JOINTS OF THE EXTERIOR GRANITE STONE STAIRS AT MAIN ENTRANCE OF THE 1890'S LIBRARY BUILDING. CUT, REMOVE AND DISPOSE OF 100% ALL EXISTING VERTICAL AND HORIZONTAL JOINT SEALANTS, INCLUDING UNDERLYING MORTAR A MINIMUM OF 1-1/2-INCHES OR UNTIL SOUND MORTAR FROM ALL GRANITE STONE STAIRS. APPLY NEW POINTING MORTAR TO WITHIN 1/2-INCH OF THE SURFACE AND APPLY POLYURETHANE SEALANT TO ALL GRANITE STONE JOINTS. STAIRS SHALL BE POWER WASHED CLEANED. SEE ENLARGE PLAN 1/ A401 AND DETAIL 5a & 5b / A4-01.
- ROUTE AND CLEAN EXISTING CRACKS IN ANY ARCHITECTURAL CAST STONE ( 1930S BUILDING ) DETAIL OR ELEMENT, AND FILL CRACKS WITH INJECTION RESTORATION REPAIR MORTAR. TOTAL QUANTITY OF <u>25 LINEAL FEET</u> IN SELECT AND RANDOM LOCATIONS ACROSS ALL ELEVATION SELECTED BY THE ARCHITECT. SEE DETAIL 1a & 1b/ A4-01. REFER TO UNIT PRICE SPECIFICATION 01 22 00.
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- CUT OUT AND DISPOSE SPALLS, CHIPS AND DELAMINATIONS IN THE ARCHITECTURAL CAST STONE WINDOW SILL. CUT OUT A MINIMUM 1/2" DEEP & SQUARE OFF ALL EDGES. CLEAN SURFACE & APPLY SINGLE COMPONENT, CEMENTITIOUS MINERAL BASED REPAIR MORTAR TOTAL QUANTITY OF 208 CUBIC INCHES IN SELECT AND RANDOM LOCATIONS ACROSS ALL ELEVATION SELECTED BY THE ARCHITECT. REFER TO UNIT PRICE SPECIFICATION 01 22 00.
- 6. RE-SEAL EXISTING ALUMINUM SPANDREL PANELS, AND GLASS PANELS AS IDENTIFIED AT 1990'S BUILDING. SEE DETAIL 8a & 8b / A4-01
- a. CUT, REMOVE & DISPOSE OF EXISTING RUBBER GASKETS FLUSH WITH PANEL FRAME. SEE DETAIL8a/ A4-01
  b. APPLY NEW BACKER ROD WHERE GASKETS ARE MISSING BETWEEN THE PANEL AND FRAME.
- c. CLEAN AND PRIME SURFACES AND APPLY NON-SAG SINGLE COMPONENT SILICONE SEALANT. COLOR TO BE SELECTED BY ARCHITECT FROM FULL RANGE OF CUSTOM COLORS.
- d. REFER TO DEDUCT ALTERNATE NO. 2.

- 7. CUT OUT AND DISPOSE SPALLS, CHIPS AND DELAMINATION IN THE ARCHITECTURAL CAST IN PLACE STONE EXIT STAIRS OF THE 1930'S BUILDING. CUT OUT A MINIMUM 1" DEEP & SQUARE OFF ALL EDGES. CLEAN SURFACE & APPLY SINGLE COMPONENT, CEMENTITIOUS MINERAL BASED REPAIR MORTAR.
- 8. REPLACE EXISTING SEALANT AND MORTAR JOINTS AT THE EXIT STAIRS OF THE 1930'S BUILDING. CUT, REMOVE AND DISPOSE OF 100% ALL EXISTING VERTICAL AND HORIZONTAL JOINT SEALANTS, INCLUDING UNDERLYING MORTAR A MINIMUM OF 1-1/2-INCHES OR UNTIL SOUND MORTAR FROM ALL ARCHITECTURAL CAST IN PLACE STONE STAIRS AND LANDING. APPLY NEW POINTING MORTAR TO WITHIN 1/2-INCH OF THE SURFACE AND APPLY POLYURETHANE SEALANT TO ALL CAST IN PLACE STONE STAIRS AND LANDING JOINTS. STAIRS SHALL BE POWER WASHED CLEANED. SEE DETAIL 3 & 4 / A4-01.

### DEDUCT ALTERNATES:

- 1. DEDUCT ALTERNATE NO.1 ELIMINATE ALL REPAIR WORK ASSOCIATED WITH THE ENTRY/EXIT STAIRS OF THE 1930'S BUILDING, INCLUDING REPLACING EXISTING SEALANT AND MORTAR JOINTS, ALL AS INCLUDED IN NOTES 7 AND 8.
- 2. DEDUCT ALTERNATE NO.2 ELIMINATE ALL WORK ASSOCIATED TO RESEAL THE EXISTING ALUMINUM SPANDREL PANELS FOR THE 1990'S BUILDING, ALL AS INCLUDED IN NOTE 6.
- 3. DEDUCT ALTERNATE NO.3 ELIMINATE TWO (2) LOCATIONS OF WORK ASSOCIATED WITH REPLACING ARCHITECTURAL CAST STONE WINDOW HEAD, ALL AS INCLUDED IN NOTE 4.

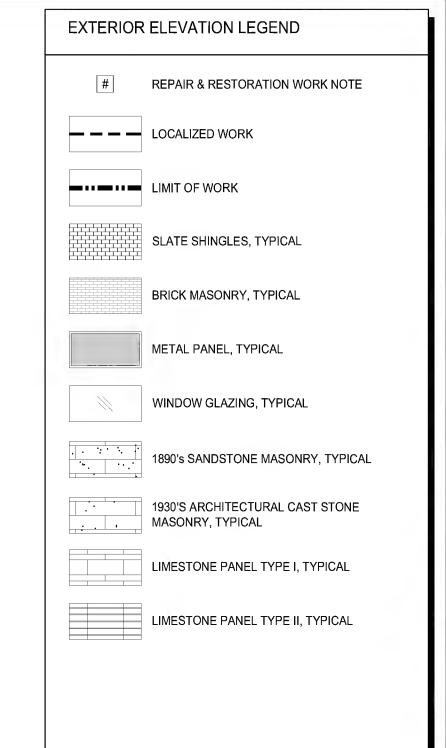

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# ROBBINS LIBRARY TOWN OF ARLINGTON

700 MASSACHUSETTS AVENUE ARLINGTON MA, 02476

EXTERIOR
ENVELOPE
REPAIRS PHASE IA
BID NO. 19-58



Drawing Title:

WEST EXTERIOR ELEVATIONS


Revisions:

ubmission:

BID DOCUMENTS

Date:	11/07/2019
Project Number:	17152-A
Project Manager:	ALS
Drawn By:	LY/BDO
Scale:	1/8"=1'-0"

A2-03

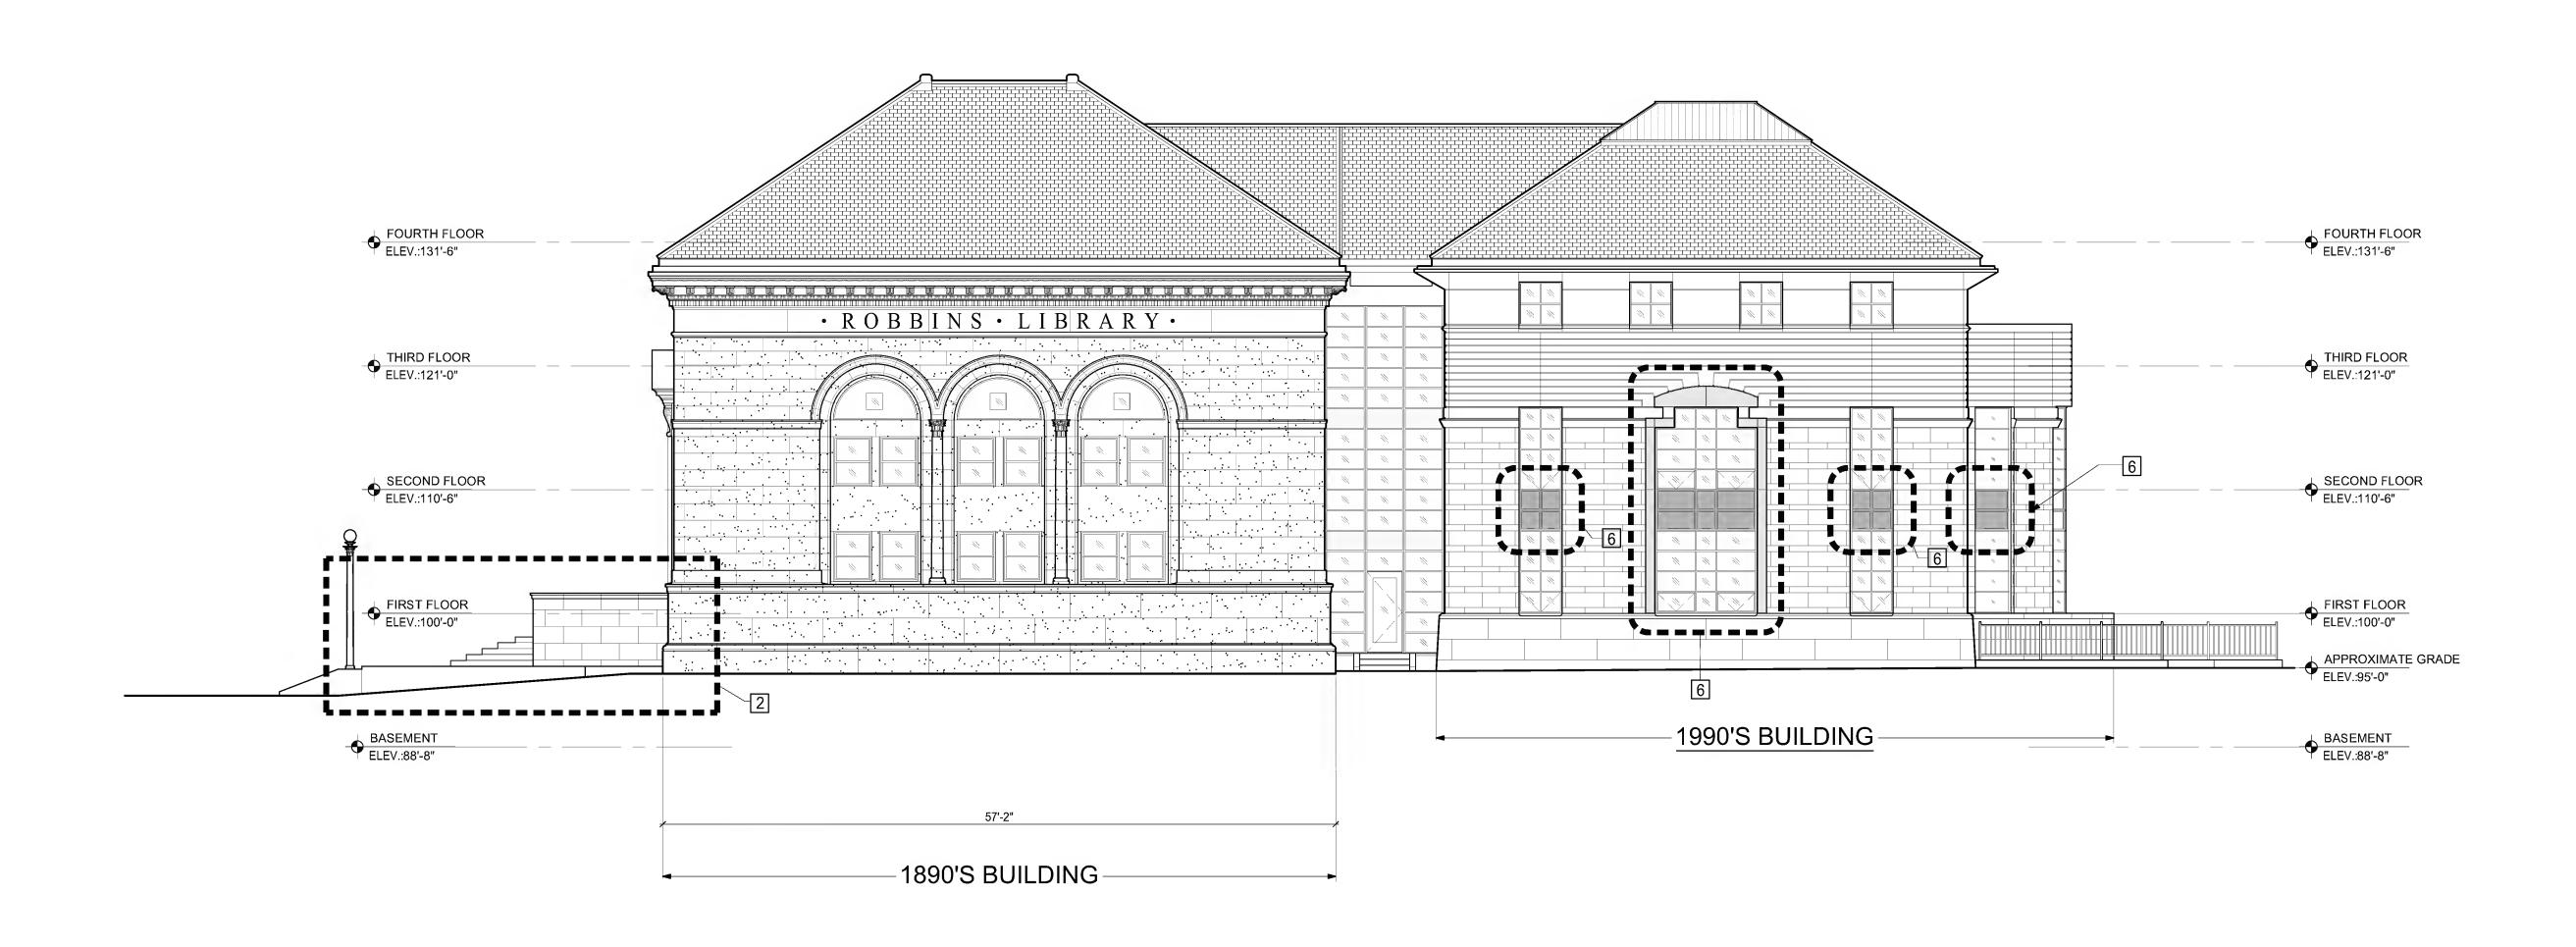




### REPAIR AND RESTORATION WORK NOTES:

- ROUTE AND CLEAN EXISTING CRACKS IN ANY SANDSTONE (1890'S BUILDING) DETAIL OR ELEMENT, AND FILL CRACKS WITH INJECTION DESCRIPTION DETAILS ASSET TO THE PROPERTY OF THE PROPERTY CRACKS WITH INJECTION RESTORATION REPAIR MORTAR. TOTAL QUANTITY OF <u>50 LINEAL FEET</u> IN SELECT AND RANDOM LOCATIONS ACROSS ALL ELEVATIONS AS SELECTED BY ARCHITECT. REFER TO UNIT PRICES –
- 2. REPLACE EXISTING SEALANT AND MORTAR JOINTS OF THE EXTERIOR GRANITE STONE STAIRS AT MAIN ENTRANCE OF THE 1890'S LIBRARY BUILDING. CUT, REMOVE AND DISPOSE OF 100% ALL EXISTING VERTICAL AND HORIZONTAL JOINT SEALANTS, INCLUDING UNDERLYING MORTAR A MINIMUM OF 1-1/2-INCHES OR UNTIL SOUND MORTAR FROM ALL GRANITE STONE STAIRS. APPLY NEW POINTING MORTAR TO WITHIN 1/2-INCH OF THE SURFACE AND APPLY POLYURETHANE SEALANT TO ALL GRANITE STONE JOINTS. STAIRS SHALL BE POWER WASHED CLEANED. SEE ENLARGE PLAN 1/ A401 AND DETAIL 5a & 5b / A4-01.
- ROUTE AND CLEAN EXISTING CRACKS IN ANY ARCHITECTURAL CAST STONE ( 1930S BUILDING ) DETAIL OR ELEMENT, AND FILL CRACKS WITH INJECTION RESTORATION REPAIR MORTAR. TOTAL QUANTITY OF <u>25 LINEAL</u> FEET IN SELECT AND RANDOM LOCATIONS ACROSS ALL ELEVATION SELECTED BY THE ARCHITECT. SEE DETAIL 1a & 1b/ A4-01. REFER TO UNIT PRICE - SPECIFICATION 01 22 00.
- REMOVE AND DISPOSE OF EXISTING ARCHITECTURAL CAST STONE WINDOW HEAD IN TWO (2) LOCATIONS AS SELECTED BY THE ARCHITECT. TEMPORARILY SHORE AND SUPPORT OPENING, FABRICATE AND INSTALL NEW REINFORCED ARCHITECTURAL PRECAST HEADER TO MATCH SIZE, TEXTURE, AND COLOR. SEE DETAIL 9A/ A4-01. REFER TO UNIT PRICE - SPECIFICATION 01 22 00 AND DEDUCT ALTERNATE NO. 3
- CUT OUT AND DISPOSE SPALLS, CHIPS AND DELAMINATIONS IN THE ARCHITECTURAL CAST STONE WINDOW SILL CUT OUT A MINIMUM 4/0" DEED 2 COLLEGE OF THE ARCHITECTURAL CAST STONE WINDOW SILL. CUT OUT A MINIMUM 1/2" DEEP & SQUARE OFF ALL EDGES. CLEAN SURFACE & APPLY SINGLE COMPONENT, CEMENTITIOUS MINERAL BASED REPAIR MORTAR TOTAL QUANTITY OF 208 CUBIC INCHES IN SELECT AND RANDOM LOCATIONS ACROSS ALL ELEVATION SELECTED BY THE ARCHITECT. REFER TO UNIT PRICE - SPECIFICATION 01 22 00.
- 6. RE-SEAL EXISTING ALUMINUM SPANDREL PANELS, AND GLASS PANELS AS IDENTIFIED AT 1990'S BUILDING. SEE DETAIL 8a & 8b / A4-01
  - CUT, REMOVE & DISPOSE OF EXISTING RUBBER GASKETS FLUSH WITH PANEL FRAME. SEE DETAIL8a/ A4-01 APPLY NEW BACKER ROD WHERE GASKETS ARE MISSING BETWEEN THE PANEL AND FRAME.
  - CLEAN AND PRIME SURFACES AND APPLY NON-SAG SINGLE COMPONENT SILICONE SEALANT. COLOR TO BE SELECTED BY ARCHITECT FROM FULL RANGE OF CUSTOM COLORS.
- d. REFER TO DEDUCT ALTERNATE NO. 2.

- 7. CUT OUT AND DISPOSE SPALLS, CHIPS AND DELAMINATION IN THE ARCHITECTURAL CAST IN PLACE STONE EXIT STAIRS OF THE 1930'S BUILDING. CUT OUT A MINIMUM 1" DEEP & SQUARE OFF ALL EDGES. CLEAN SURFACE & APPLY SINGLE COMPONENT, CEMENTITIOUS MINERAL BASED REPAIR MORTAR.
- 8. REPLACE EXISTING SEALANT AND MORTAR JOINTS AT THE EXIT STAIRS OF THE 1930'S BUILDING. CUT, REMOVE AND DISPOSE OF 100% ALL EXISTING VERTICAL AND HORIZONTAL JOINT SEALANTS, INCLUDING UNDERLYING MORTAR A MINIMUM OF 1-1/2-INCHES OR UNTIL SOUND MORTAR FROM ALL ARCHITECTURAL CAST IN PLACE STONE STAIRS AND LANDING. APPLY NEW POINTING MORTAR TO WITHIN 1/2-INCH OF THE SURFACE AND APPLY POLYURETHANE SEALANT TO ALL CAST IN PLACE STONE STAIRS AND LANDING JOINTS. STAIRS SHALL BE POWER WASHED CLEANED. SEE DETAIL 3 & 4 / A4-01.

### **DEDUCT ALTERNATES:**

- 1. DEDUCT ALTERNATE NO.1 ELIMINATE ALL REPAIR WORK ASSOCIATED WITH THE ENTRY/EXIT STAIRS OF THE 1930'S BUILDING, INCLUDING REPLACING EXISTING SEALANT AND MORTAR JOINTS, ALL AS INCLUDED IN NOTES 7 AND 8.
- 2. DEDUCT ALTERNATE NO.2 ELIMINATE ALL WORK ASSOCIATED TO RESEAL THE EXISTING ALUMINUM SPANDREL PANELS FOR THE 1990'S BUILDING, ALL AS INCLUDED IN NOTE 6.
- 3. DEDUCT ALTERNATE NO.3 ELIMINATE TWO (2) LOCATIONS OF WORK ASSOCIATED WITH REPLACING ARCHITECTURAL CAST STONE WINDOW HEAD, ALL AS INCLUDED IN NOTE 4.

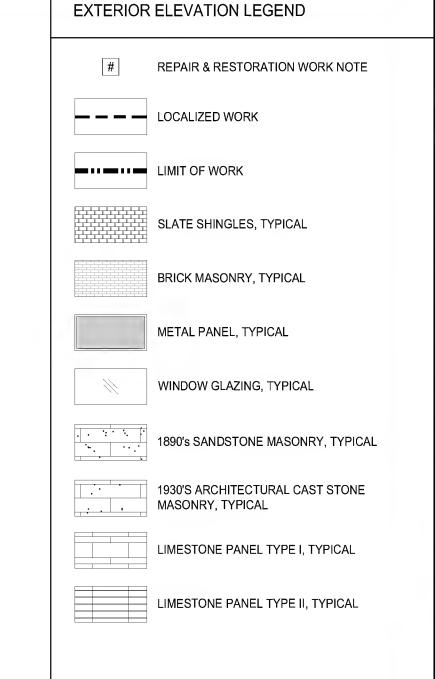

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700 MASSACHUSETTS AVENUE ARLINGTON MA, 02476

**EXTERIOR ENVELOPE REPAIRS** -PHASE IA BID NO. 19-58



Drawing Title:

NORTH **EXTERIOR ELEVATIONS** 

Revisions:

BID **DOCUMENTS** 

